

WICHIGAN INSTITUTE OF THE COUNTY OF THE COUN

DeGroot Drain

Sections 14-15 & 23 T7N, R13W

Tallmadge Township, Ottawa County, Michigan

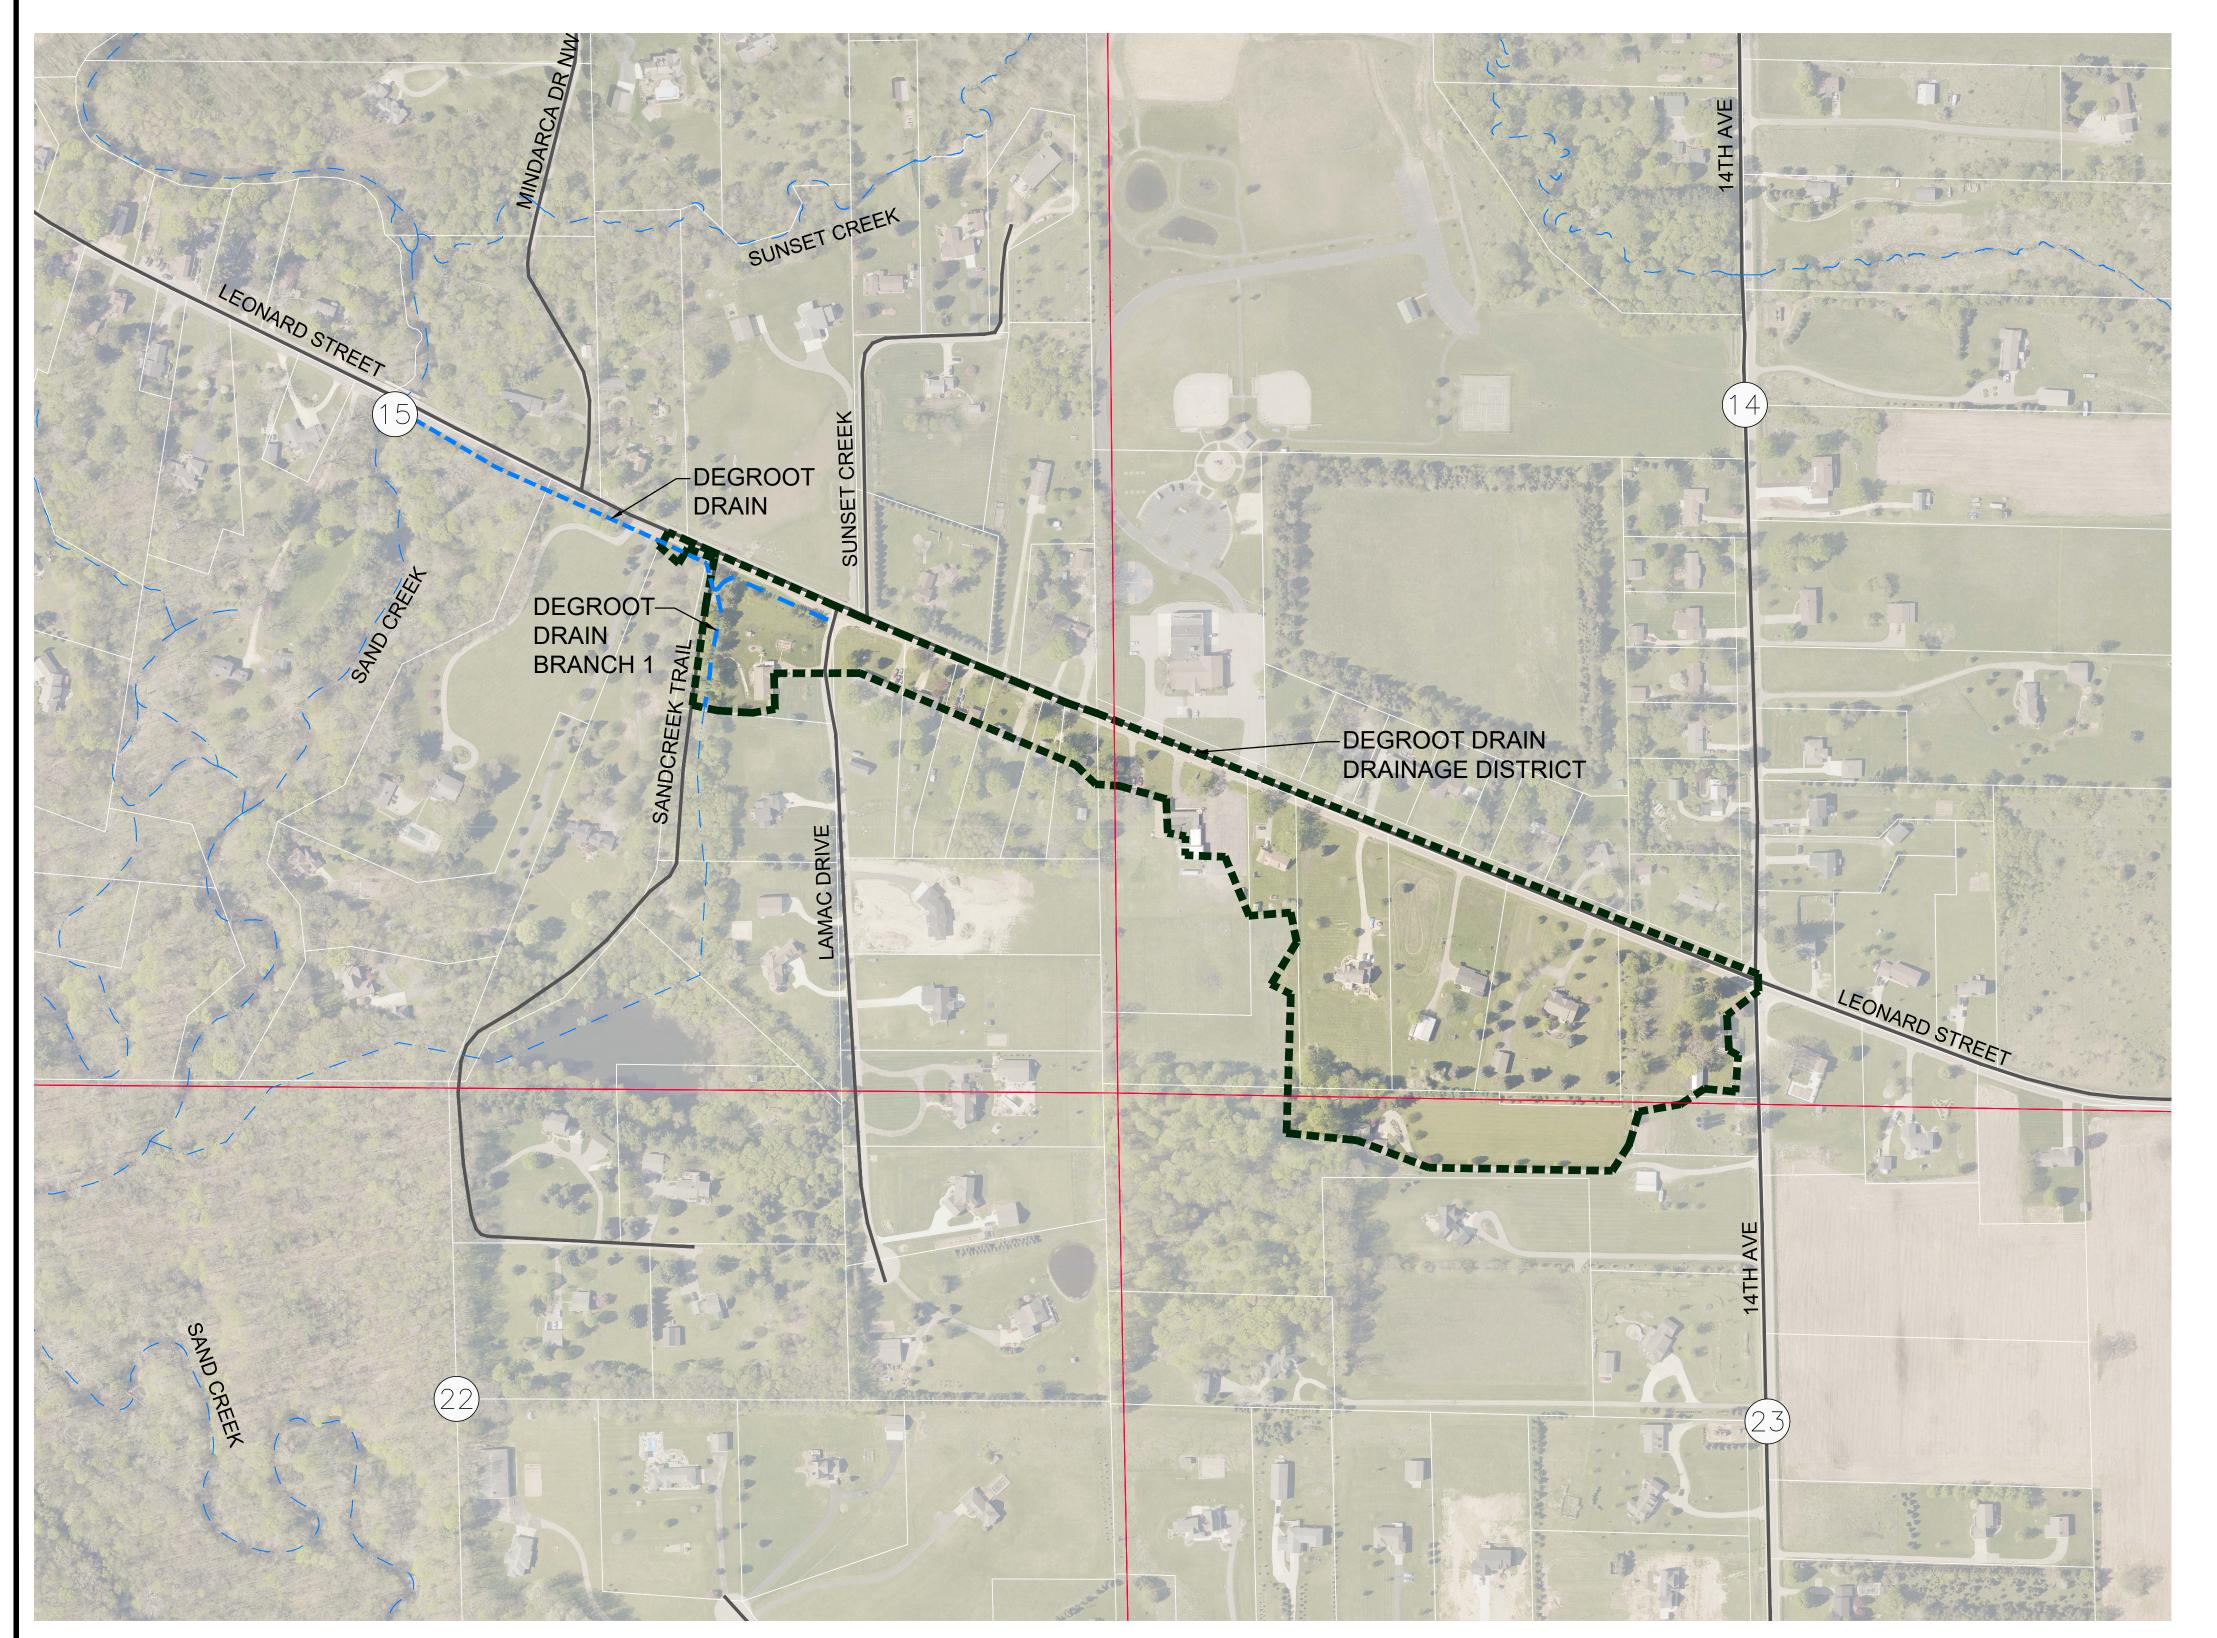

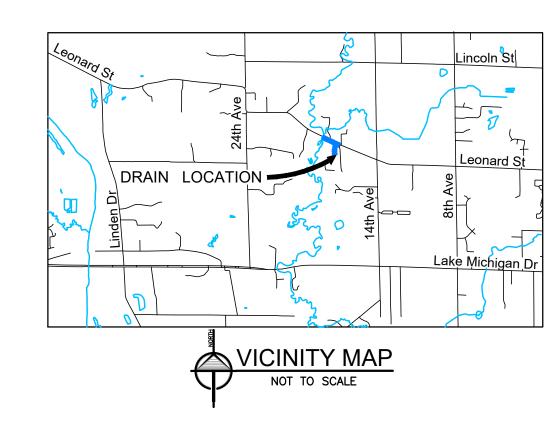

INDEX OF SHEETS

CS - COVER SHEET

C1 - PLAN & PROFILE

DEGROOT DRAIN
(STA. 0+00 - 10+50)

C2 - PLAN & PROFILE

DEGROOT DRAIN-BRANCH #1

(STA. 0+00 - 6+50)

C3 - DETAILS

C4 - SESC PLAN

LEGEND

ENCLOSED CHANNEL DRAIN

OPEN CHANNEL DRAIN

DRAINAGE DISTRICT

BOUNDARY


SECTION LINE

TOWNSHIP LINE

ROADS
PROPERTY LINES

SECTION NUMBERS

SHEET NUMBERS

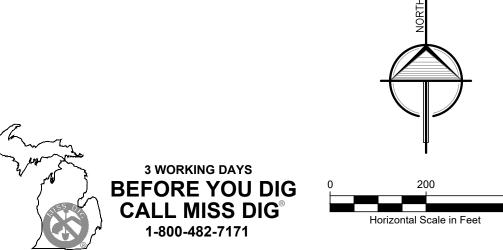

ALL UTILITIES AS SHOWN ARE APPROXIMATE LOCATIONS DERIVED FROM ACTUAL MEASUREMENTS AND AVAILABLE RECORDS. THEY SHOULD NOT BE INTERPRETED TO BE EXACT LOCATION NOR SHOULD IT BE ASSUMED THAT THEY ARE THE ONLY UTILITIES IN THE AREA.

Walker, M
Ph: 616-30
www.LREI

ENGINEERS & SURVEYORS

OR	DATE
ARY REVIEW	9/8/2022
(EVIEW	8/10/2023
(EVIEW	10/20/2023
OR BID	2/1/2024


// IMISSIONER	NO.	ISSUED FOR
0	1.	PRELIMINARY REVIEW
	2.	OWNER REVIEW
	3.	OWNER REVIEW
	4.	ISSUED FOR BID

	DATE
SURVEYED BY: CVF, ADK	01/2022
DESIGNED BY: TRM	10/2023
DRAFTED BY: LGG	01/2022
OAOC: DJF/MPB	1/2024

COVER SHEET

SHEET NUMBER



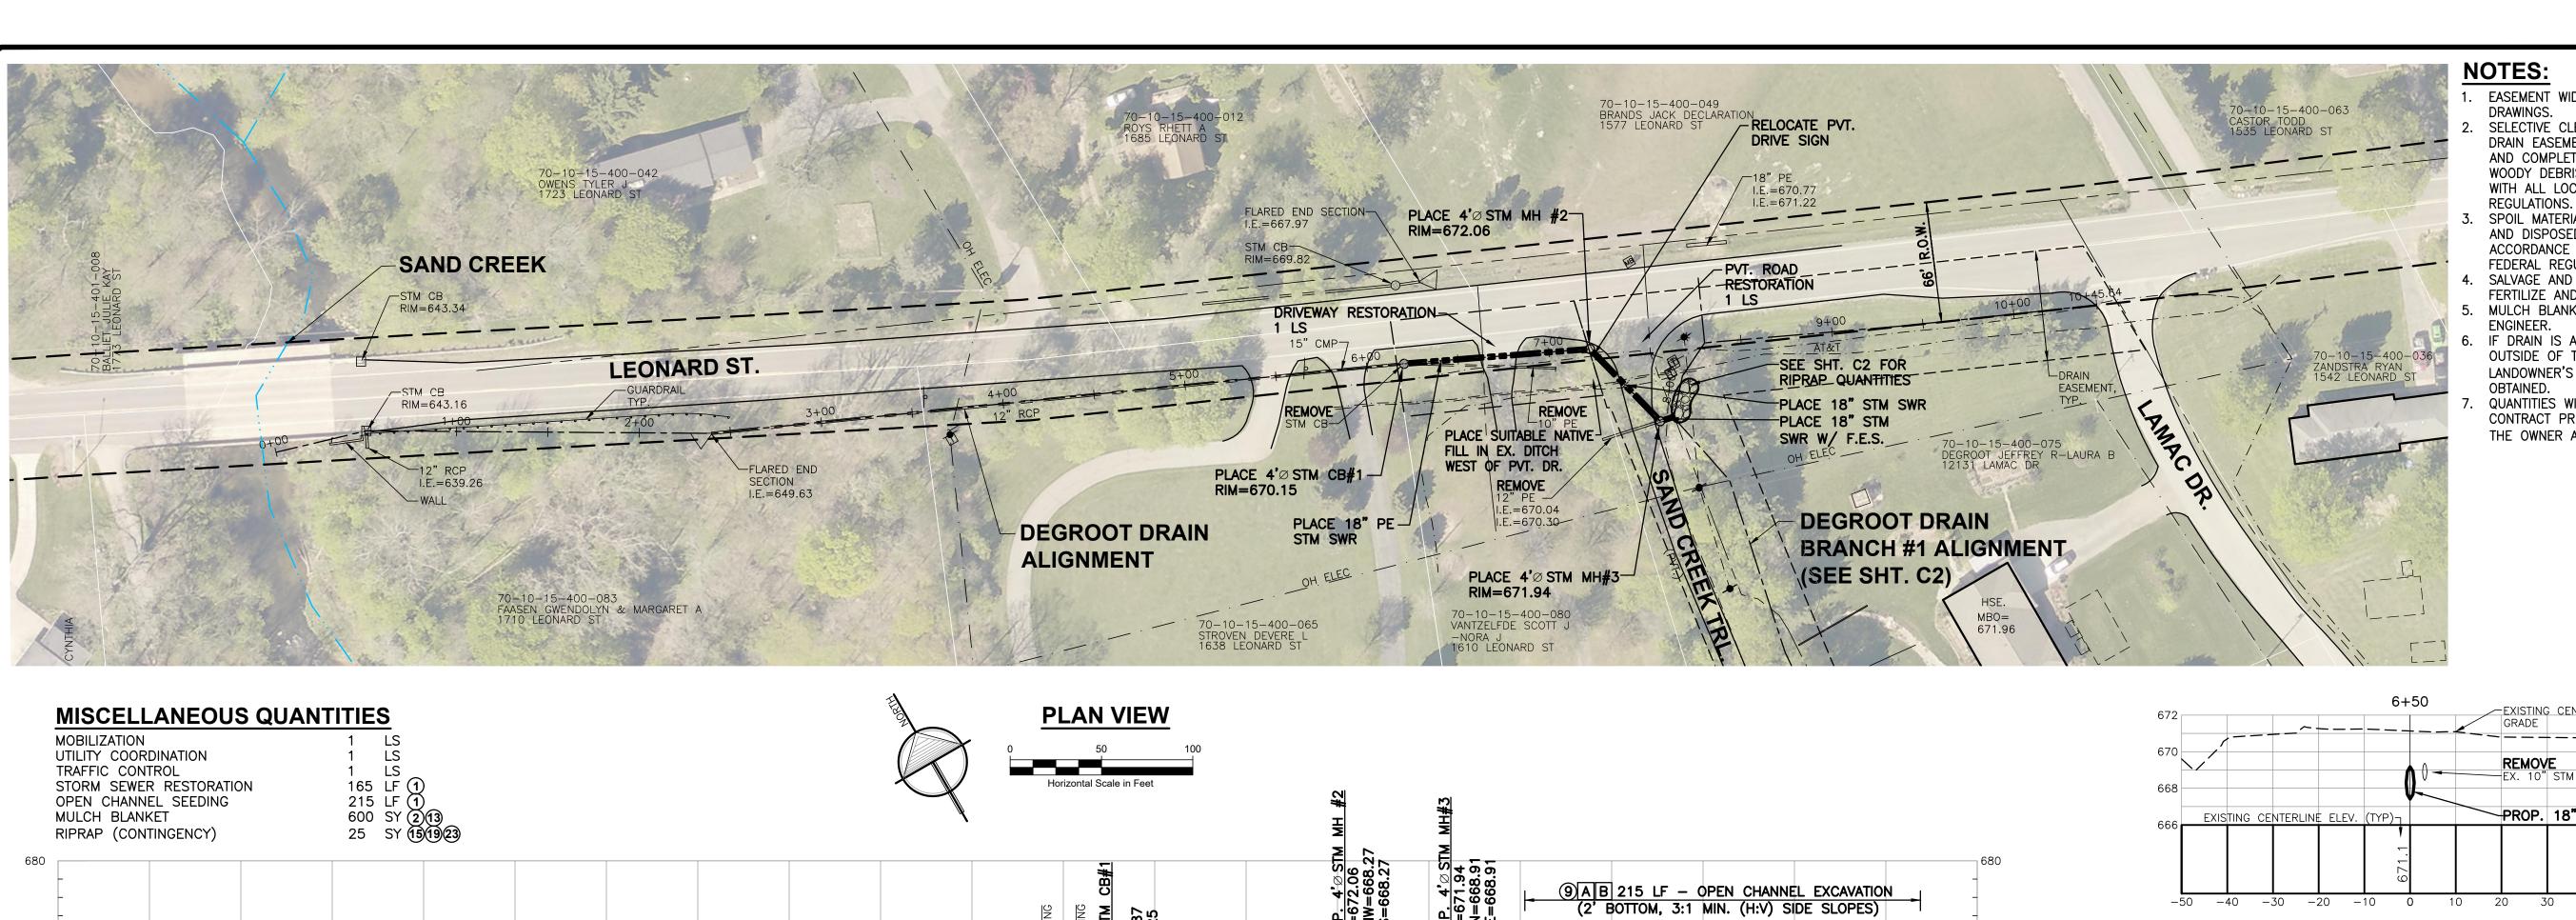

REMOVE

334 LF 12" RCP

EXISTING CENTERLINE ELEVATIONS-

5+00

CROSS SECTIONS


SCALE: HORIZONTAL: 1" = 50' VERTICAL: 1" = 5'

4+00

PROP. 102 LF 18" PE STM SWR @ 1.00%

7+00

- EASEMENT WIDTH: AS INDICATED ON
- 2. SELECTIVE CLEAR, GRUB AND SNAG THE DRAIN EASEMENT AS NECESSARY TO ACCESS AND COMPLETE THE WORK. DISPOSE OF WOODY DEBRIS OFF SITE IN ACCORDANCE WITH ALL LOCAL, STATE AND FEDERAL
- 3. SPOIL MATERIAL SHALL BE HAULED OFFSITE AND DISPOSED IN UPLAND AREA IN ACCORDANCE WITH ALL LOCAL, STATE & FEDERAL REGULATIONS.
- SALVAGE AND RE-SPREAD TOPSOIL,
- FERTILIZE AND SEED ALL DISTURBED AREAS. MULCH BLANKET AREAS AS DIRECTED BY
- IF DRAIN IS ACCESSED ACROSS PROPERTY OUTSIDE OF THE DRAIN EASEMENT, A LANDOWNER'S AGREEMENT FORM MUST BE
- QUANTITIES WILL NOT BE PAID ABOVE THE CONTRACT PRICE UNLESS AUTHORIZED BY THE OWNER AND/OR ENGINEER.

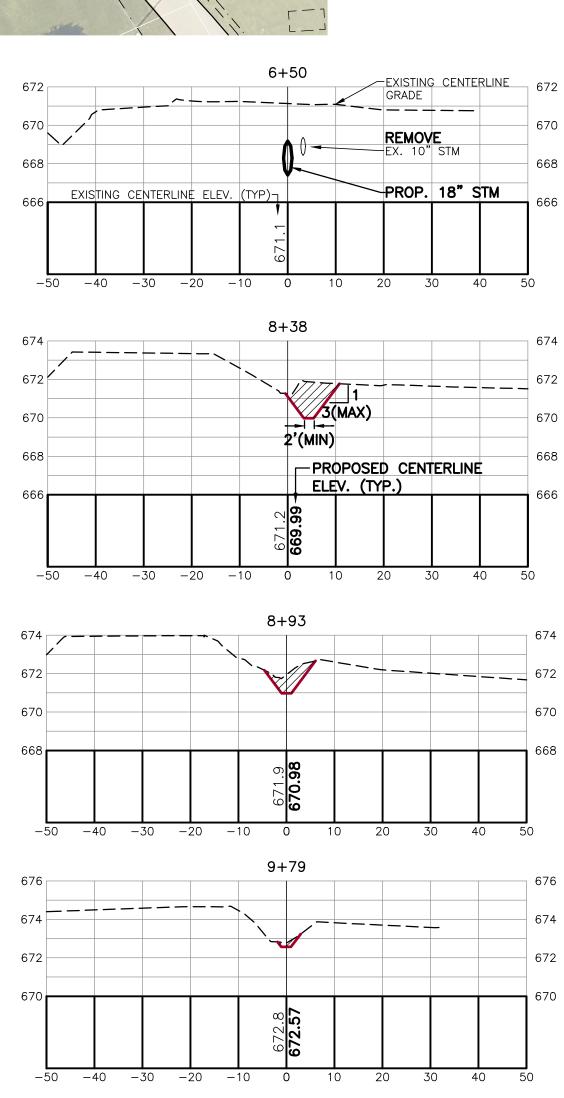

PROP. CENTERLINE

GRADE

PROPOSED CENTERLINE ELEVATIONS

10+00

10+50

9+00

-PROP. RIPRAP DISSIPATOR

-PROP. FLARED

END SECTION

LI.E.=669.00

8+00

STM SWR @ 1.19%

STM SWR @ 1.16%

-PROP. 55 LF 18" RCP

CROSS SECTIONS

SCALE: HORIZONTAL: 1" = 20' VERTICAL: 1" = 5'



3 WORKING DAYS BEFORE YOU DIG CALL MISS DIG® 1-800-482-7171

ALL UTILITIES AS SHOWN ARE APPROXIMATE LOCATIONS DERIVED FROM ACTUAL MEASUREMENTS AND AVAILABLE RECORDS. THEY SHOULD NOT BE INTERPRETED TO BE EXACT LOCATION NOR SHOULD IT BE ASSUMED THAT THEY ARE THE ONLY UTILITIES IN THE AREA.

SHEET NUMBER

PLAN & PROFILE DEGROOT DRAIN STA: 0+00 - 10+00

WATER RESOURCES COMMISSIONER MORE STREET, WEST OLIVE, MICHIGAN, 49460

OTTAWA

DEGROOT DRAIN

640

0+00


1+00

EXISTING CENTERLINE GRADE


2+00

─I.E.=649.63


3+00

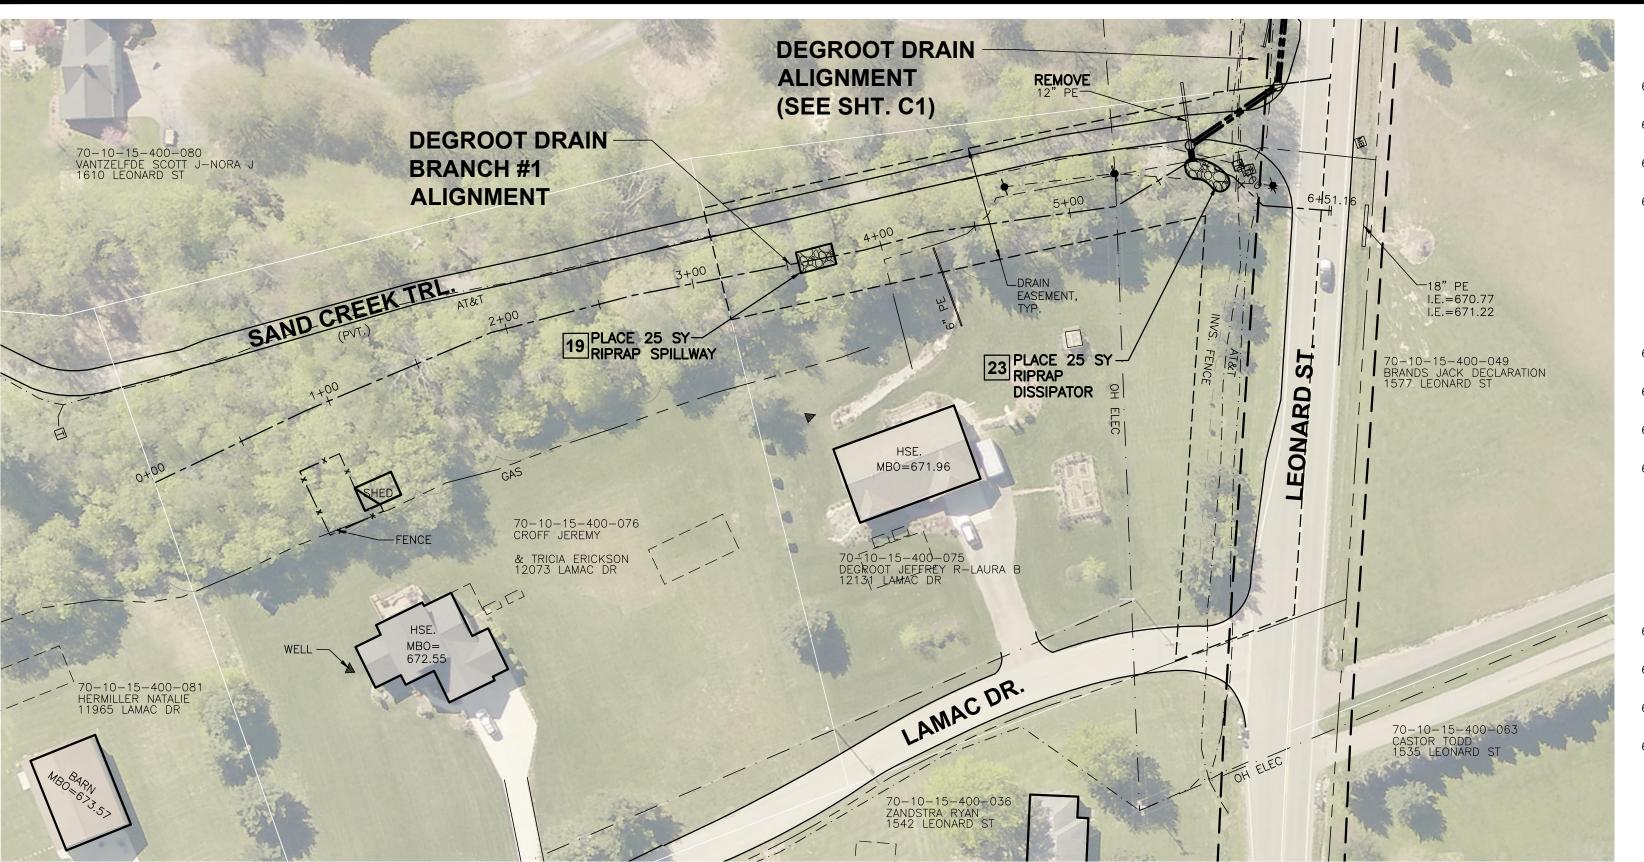



0+21 -50 -40 -30 -20 -10 0

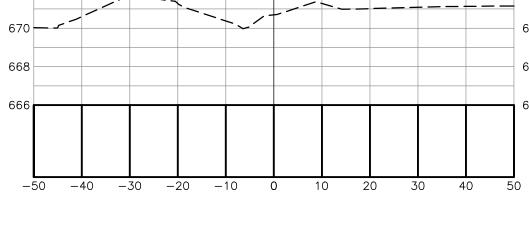


2+71

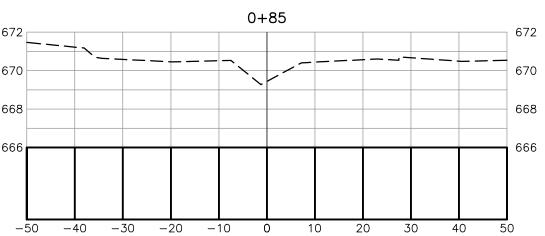

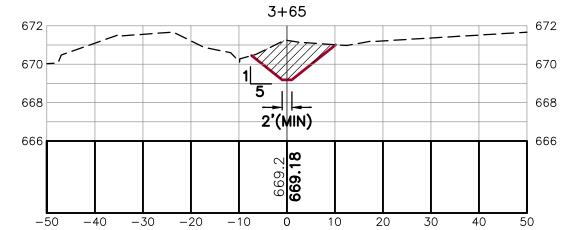

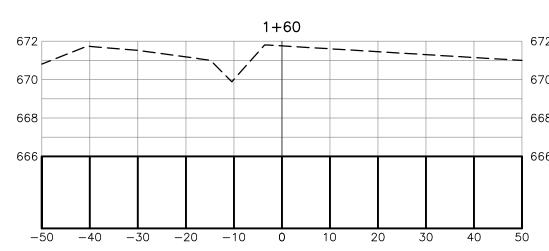

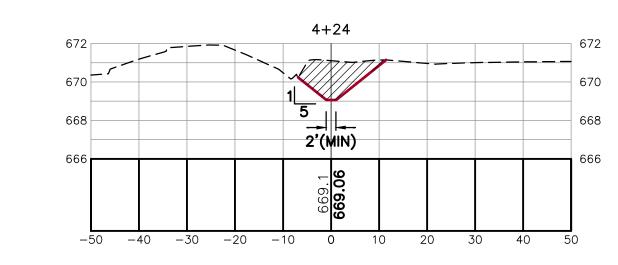


MISCELLANEOUS QUANTITIES


OPEN CHANNEL SEEDING MULCH BLANKET

235 LF (1) 500 SY (2)(3)



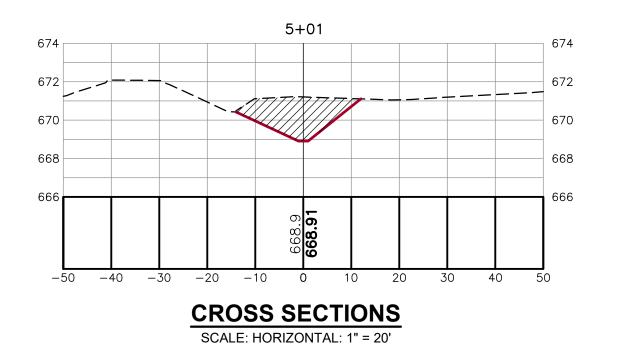

VERTICAL: 1" = 5'

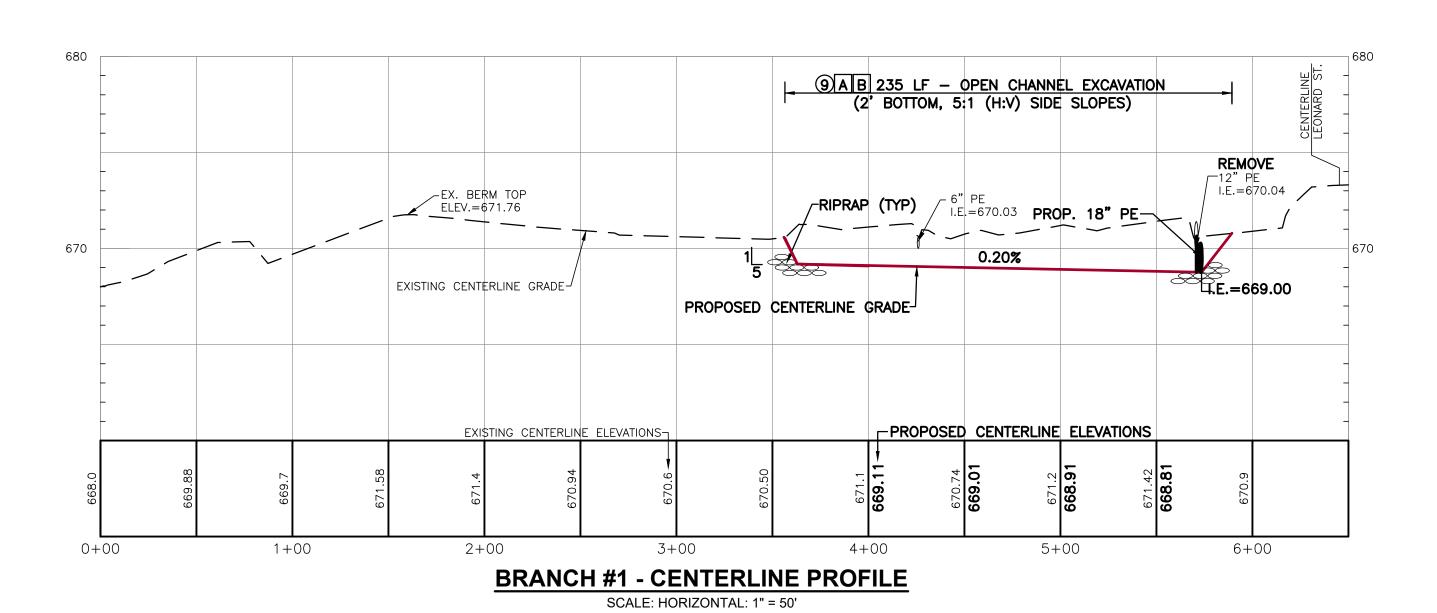

VERTICAL: 1" = 5'

NOTES:

- . EASEMENT WIDTH: AS INDICATED ON DRAWINGS.
- 2. SELECTIVE CLEAR, GRUB AND SNAG THE DRAIN EASEMENT AS NECESSARY TO ACCESS AND COMPLETE THE WORK. DISPOSE OF WOODY DEBRIS OFF SITE IN ACCORDANCE WITH ALL LOCAL, STATE AND FEDERAL REGULATIONS.
- 3. SPOIL MATERIAL SHALL BE HAULED OFFSITE AND DISPOSED IN UPLAND AREA IN ACCORDANCE WITH ALL LOCAL, STATE & FEDERAL REGULATIONS.
- 4. SALVAGE AND RE-SPREAD TOPSOIL, FERTILIZE AND SEED ALL DISTURBED
- 5. MULCH BLANKET AREAS AS DIRECTED BY ENGINEER.
- 6. IF DRAIN IS ACCESSED ACROSS PROPERTY OUTSIDE OF THE DRAIN EASEMENT,
- 7. QUANTITIES WILL NOT BE PAID ABOVE THE CONTRACT PRICE UNLESS

A LANDOWNER'S AGREEMENT FORM MUST BE OBTAINED. AUTHORIZED BY THE OWNER AND/OR ENGINEER.




ALL UTILITIES AS SHOWN ARE APPROXIMATE LOCATIONS DERIVED FROM ACTUAL MEASUREMENTS AND AVAILABLE RECORDS. THEY SHOULD NOT BE INTERPRETED TO BE EXACT LOCATION NOR SHOULD IT BE ASSUMED THAT THEY ARE THE ONLY UTILITIES IN THE AREA.



SHEET NUMBER

WATER RESOURCES COMMISSIONER MORE STREET, WEST OLIVE, MICHIGAN, 49460

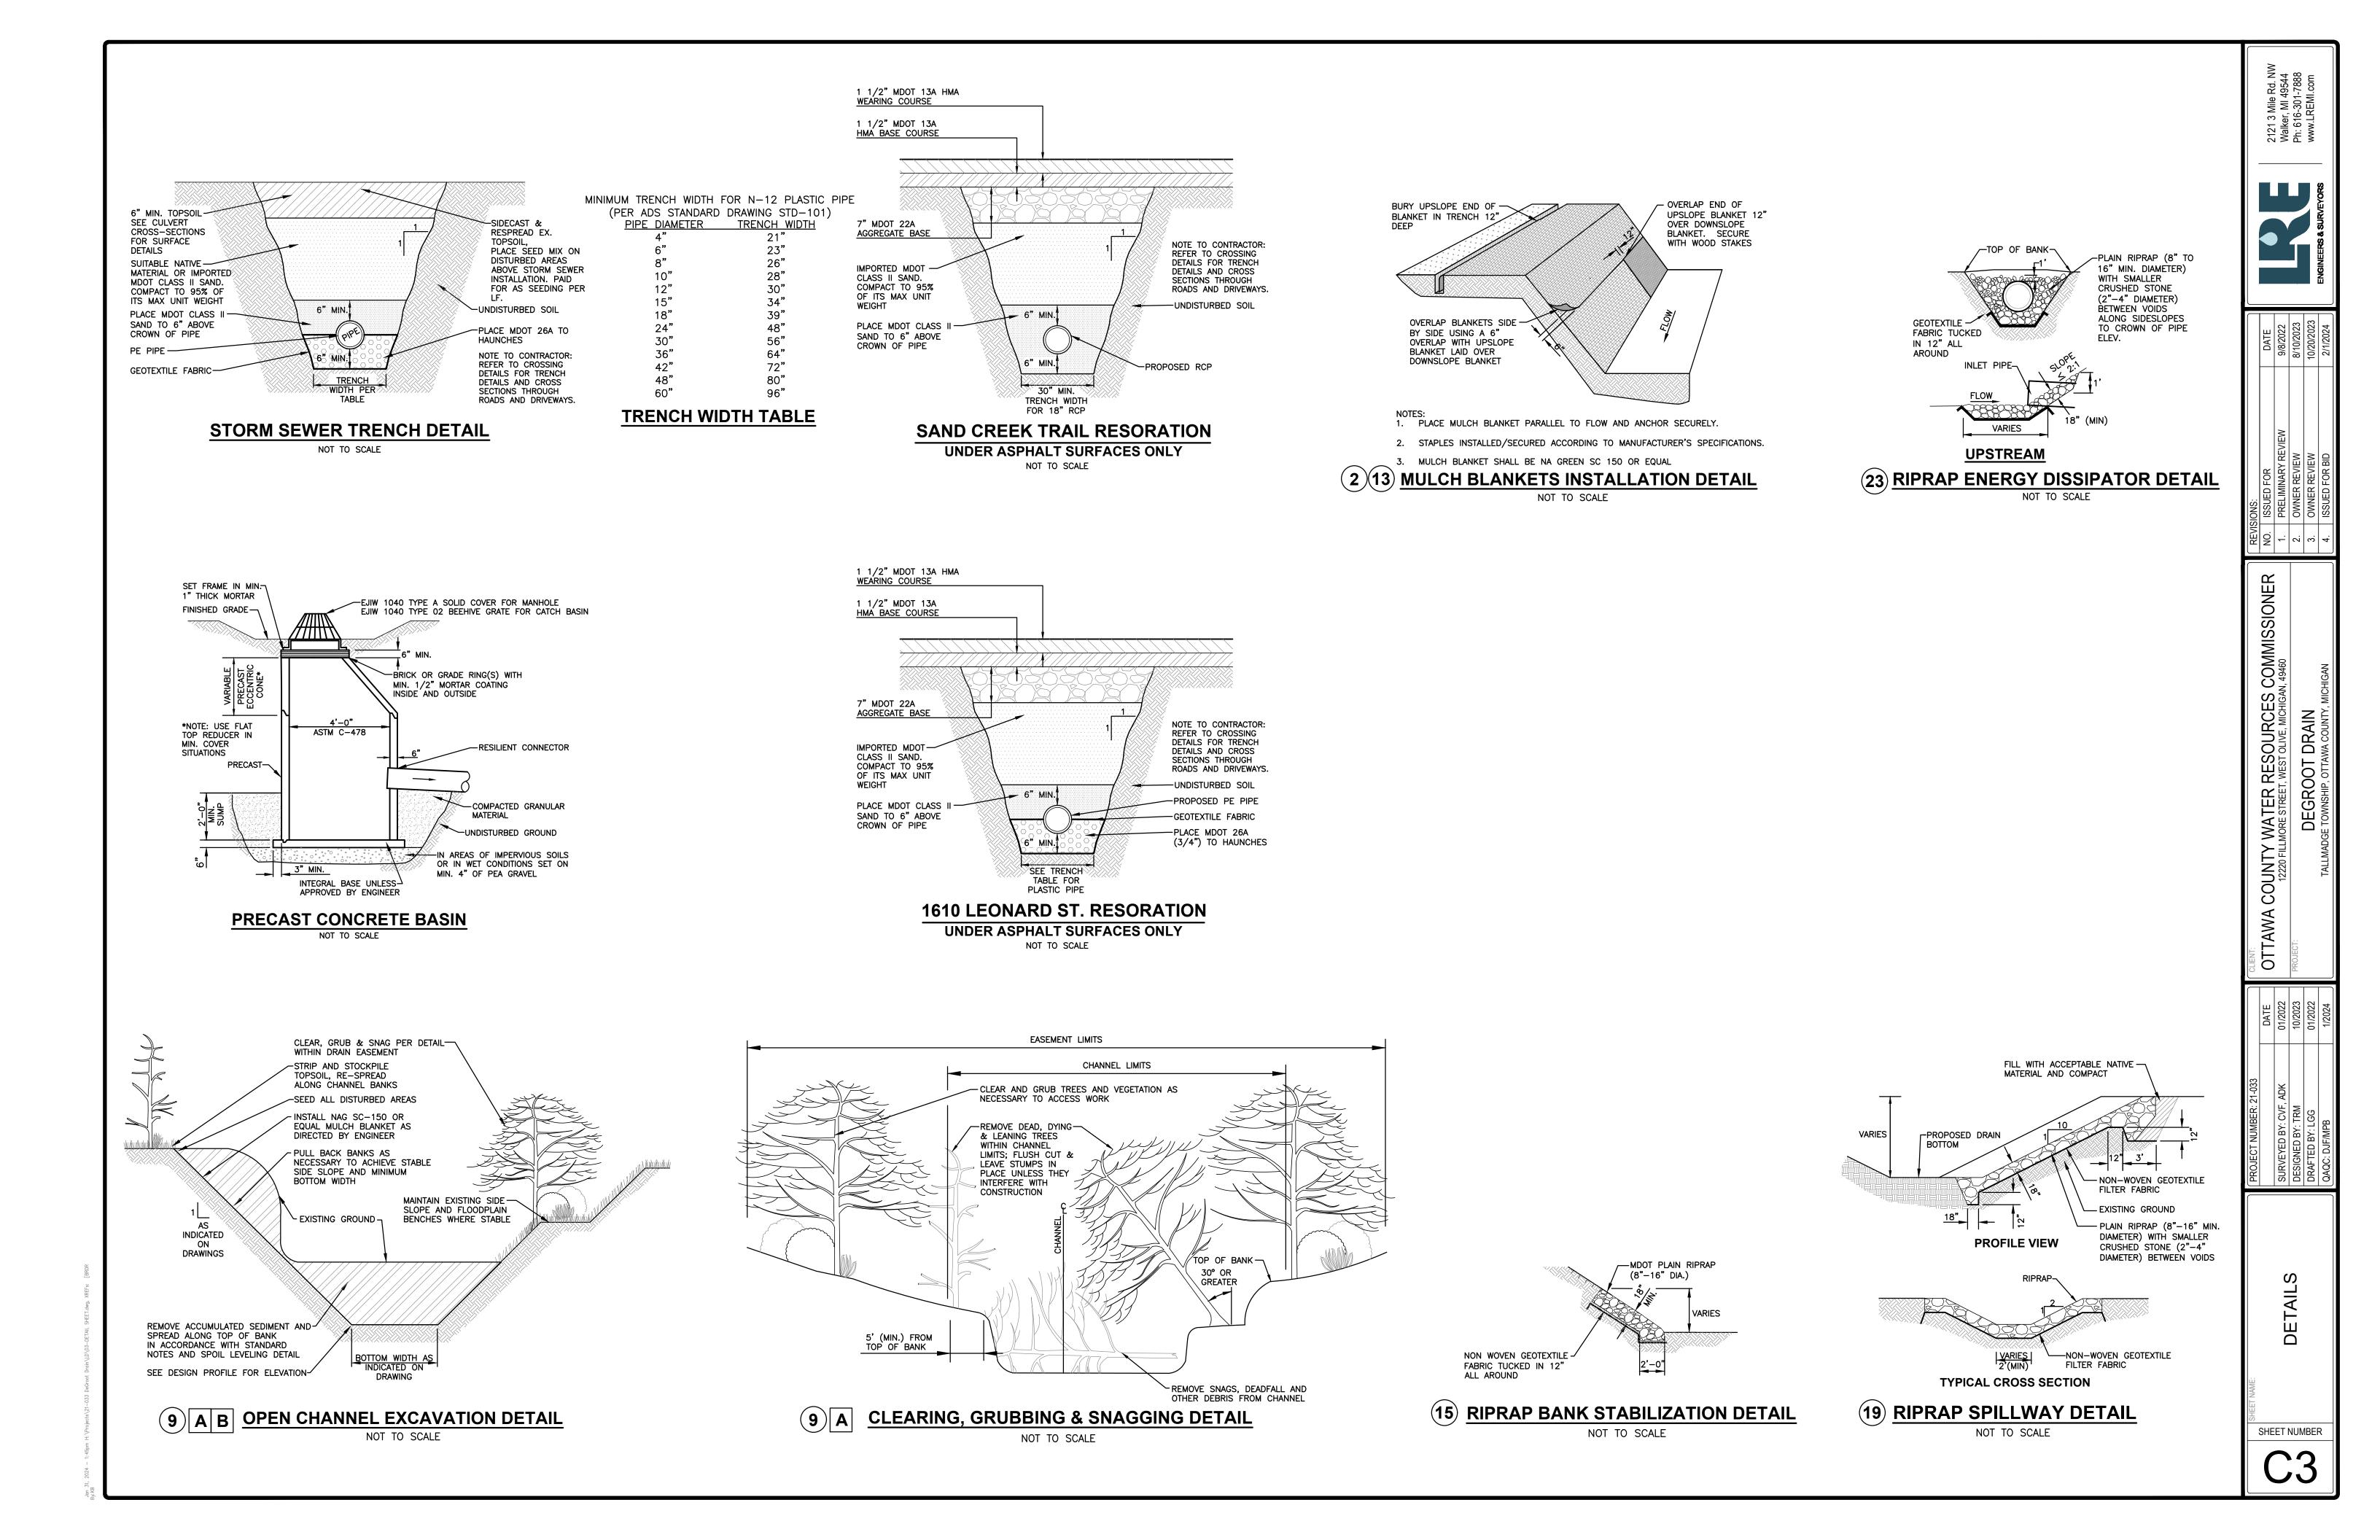

NOTES

- 1. PROPOSED EARTH CHANGE LIMITED TO EASEMENT AREA.
- 2. SOIL DATA FROM USDA NRCS WEB SOIL SURVEY.
- 3. REFER TO OTTAWA COUNTY DRAIN COMMISSIONER'S STANDARD CONSTRUCTION SPECIFICATIONS FOR SESC STANDARD DETAILS.

LEGEND



SOIL TYPE (USDA NRCS WEBSOIL SURVEY)

SOILS LEGEND

	<u>== 0 =: 1=</u>
Ak	ALGANSEE LOAMY SAND
BeA	BELDING SANDY LOAM, 0-2% SLOPES
BeB	BELDING SANDY LOAM, 2-6% SLOPES
BrmaaA	BREMS-SPINKS COMPLEX, 0-2% SLOPES
Сс	CARLISLE MUCK, 0-2% SLOPES
Се	CARLISLE MUCK, 0-2% SLOPES
ChB	COLOMA LOAMY SAND, 0-6% SLOPES
Cm	COHOCTAH LOAM
FoB	FOX SANDY LOAM, 0-6% SLOPES
Ce ChB Cm	CARLISLE MUCK, 0-2% SLOPES COLOMA LOAMY SAND, 0-6% SLOPES COHOCTAH LOAM

GLENDORA SANDY LOAM
IOSCO LOAMY SAND, 0-4% SLOPES
KAWKAWLIN LOAM, 0-2% SLOPES ΙoΑ KnA KAWKAWLIN LOAM, 2-6% SLOPES KnB Ма MADE LAND MARLETTE-CAPAC-THETFORD COMPLEX MaraaB

2-6% SLOPES MANCELONA LOAMY SAND, 0-2% SLOPES MENOMINEE LOAMY SAND, 2-6% SLOPES PERRINTON LOAM, LAKE MICHIGAN LOBE, McA MmB NeB 2-6% SLOPES NeC ONEKAMA LOAM, LAKE MICHIGAN LOBE 6-12% SLOPES

NESTER LOAM, 12-18% SLOPES NESTER LOAM, 25-45% SLOPES NeD NeF NsC3 NESTER CLAY LOAM, 6-12% SLOPES, SEVERELY ERODED NsD3 NESTER CLAY LOAM, 12-18% SLOPES, SEVERELY ERODED

PlfafF PLAINFIELD-METEA-SPINKS COMPLEX 35-60% SLOPES RcA RICHTER SANDY LOAM, 0-2% SLOPES

SHOALS LOAM Sh Sm SIMS LOAM SLOAN LOAM

SnkabB SpC TknabC

SLOAN LOAM

SPINKS—FERN COMPLEX, 2—6% SLOPES

SPINKS LOAMY SAND, 6—12% SLOPES

TEKENINK—SPINKS LOAMY SAND, 6—12% SLOPES

ULBY SANDY LOAM, 0—2% SLOPES

ULBY SANDY LOAM, 2—6% SLOPES UIA UIB UIC ULBY SANDY LOAM, 6-12% SLOPES


WATER

		MACDC	UNIFIED KEYING SYS	STEM EROSION CONTROL MEASURES (SESC)
k	KEY	SESC MEASURE	SYMBOL	WHERE USED
3.	1	Seeding	with the second second	When bare soil is exposed, temporarily or permanently, to erosive forces from wind and or water on flat areas, mild slopes, grassed waterways and spillways, diversion ditches and dikes, burrow and stockpile areas, and spoil piles.
	2	Mulch		On flat areas, slopes, grassed waterways and spillways, diversion ditches & dikes, borrow & stockpile areas, & spoil piles when areas are subject to raindrop impact, & erosive forces from wind or water.
T	9	Vegetation Removal without Grubbing	Grubbing Omitted	Retains existing root mat which assists in stabilizing slopes. Assissts in the revegetation process by providing sprout growth. Reduces sheet flow velocities preventing rilling and gullying, Discourages off—road vehicle use.
	13	Slope Stablization		Slope stabilizing measures provde an immediate and effective cover over raw erodible slopes affording excellent protection against rain and wind erosion.
Y	15	Riprap		Along drain banks, shorelines, or where concentrated flows occur. slows velocity, reduces erosion and sedimentation.
	16	Riprap Toe of Slope	- makenter and a	Riprap toe of slope protection is used in areas where velocities are causing drain bank erosion and are too high to stabilize using other methods.
	19	Armored Spillway		When concentrated flow must be conveyed down a drain bank or slope of discharge into anther drain. Where slope failure or channel scour is observed or is likely to occur, or when runoff must be redirected around work in the drain.
	23	Outfall Stabilization		In the stream or drain bank usually above the ordinary high water mark where an enclosed drain or tile discharges to an open drain.

MACDC UNIFIED KEYING SYSTEM - ROUTINE MAINTENANCE ACTIVITIES

KEY	BEST MANAGEMENT PRACTICE	SESC PLAN
Α	Debris Removal	NO
В	Sediment Removal	> 100 FEET



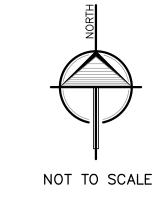

ALL UTILITIES AS SHOWN ARE APPROXIMATE LOCATIONS DERIVED FROM ACTUAL MEASUREMENTS AND AVAILABLE RECORDS. THEY SHOULD NOT BE INTERPRETED TO BE EXACT LOCATION NOR SHOULD IT BE ASSUMED THAT THEY ARE THE ONLY UTILITIES IN THE AREA.

A COUNTY WATER RESOURCES COMMISSIC 12220 FILLMORE STREET, WEST OLIVE, MICHIGAN, 49460	DEGROOT DRAIN TALLMADGE TOWNSHIP, OTTAWA COUNTY, MICHIGAN
---	---

	SURVEYED BY: CVF, ADK	01/2022
	DESIGNED BY: TRM	10/2023
	DRAFTED BY: LGG	01/2022
	QAQC: DJF/MPB	1/2024
1		

SESC

SHEET NUMBER